

# GWINNETT COUNTY DEPARTMENT OF FINANCIAL SERVICES PURCHASING DIVISION

75 Langley Drive | Lawrenceville, GA 30046-6935 O: 770.822.8720 | F: 770.822.8735 GwinnettCounty.com

November 1, 2024

## ADDENDUM #2 BL130-24, Construction of Dacula Park Activity Center Expansion

#### **REVISIONS:**

1. Changes that have been made to the bid documents are outlined below per sheet reference. These changed sheets are attached to addendum 2.

#### **MECHANICAL DRAWINGS**

M1.11: Notes updated.

M3.03: Note added.

M3.04: Note added.

This addendum should be acknowledged in the space provided on page 15 of the bid documents and returned with your bid. Failure to do so may result in your bid being deemed non-responsive.


Thank you,

Jake Scarpone

Jake Scarpone Purchasing Associate II

#### Attachments:

1. Revisions

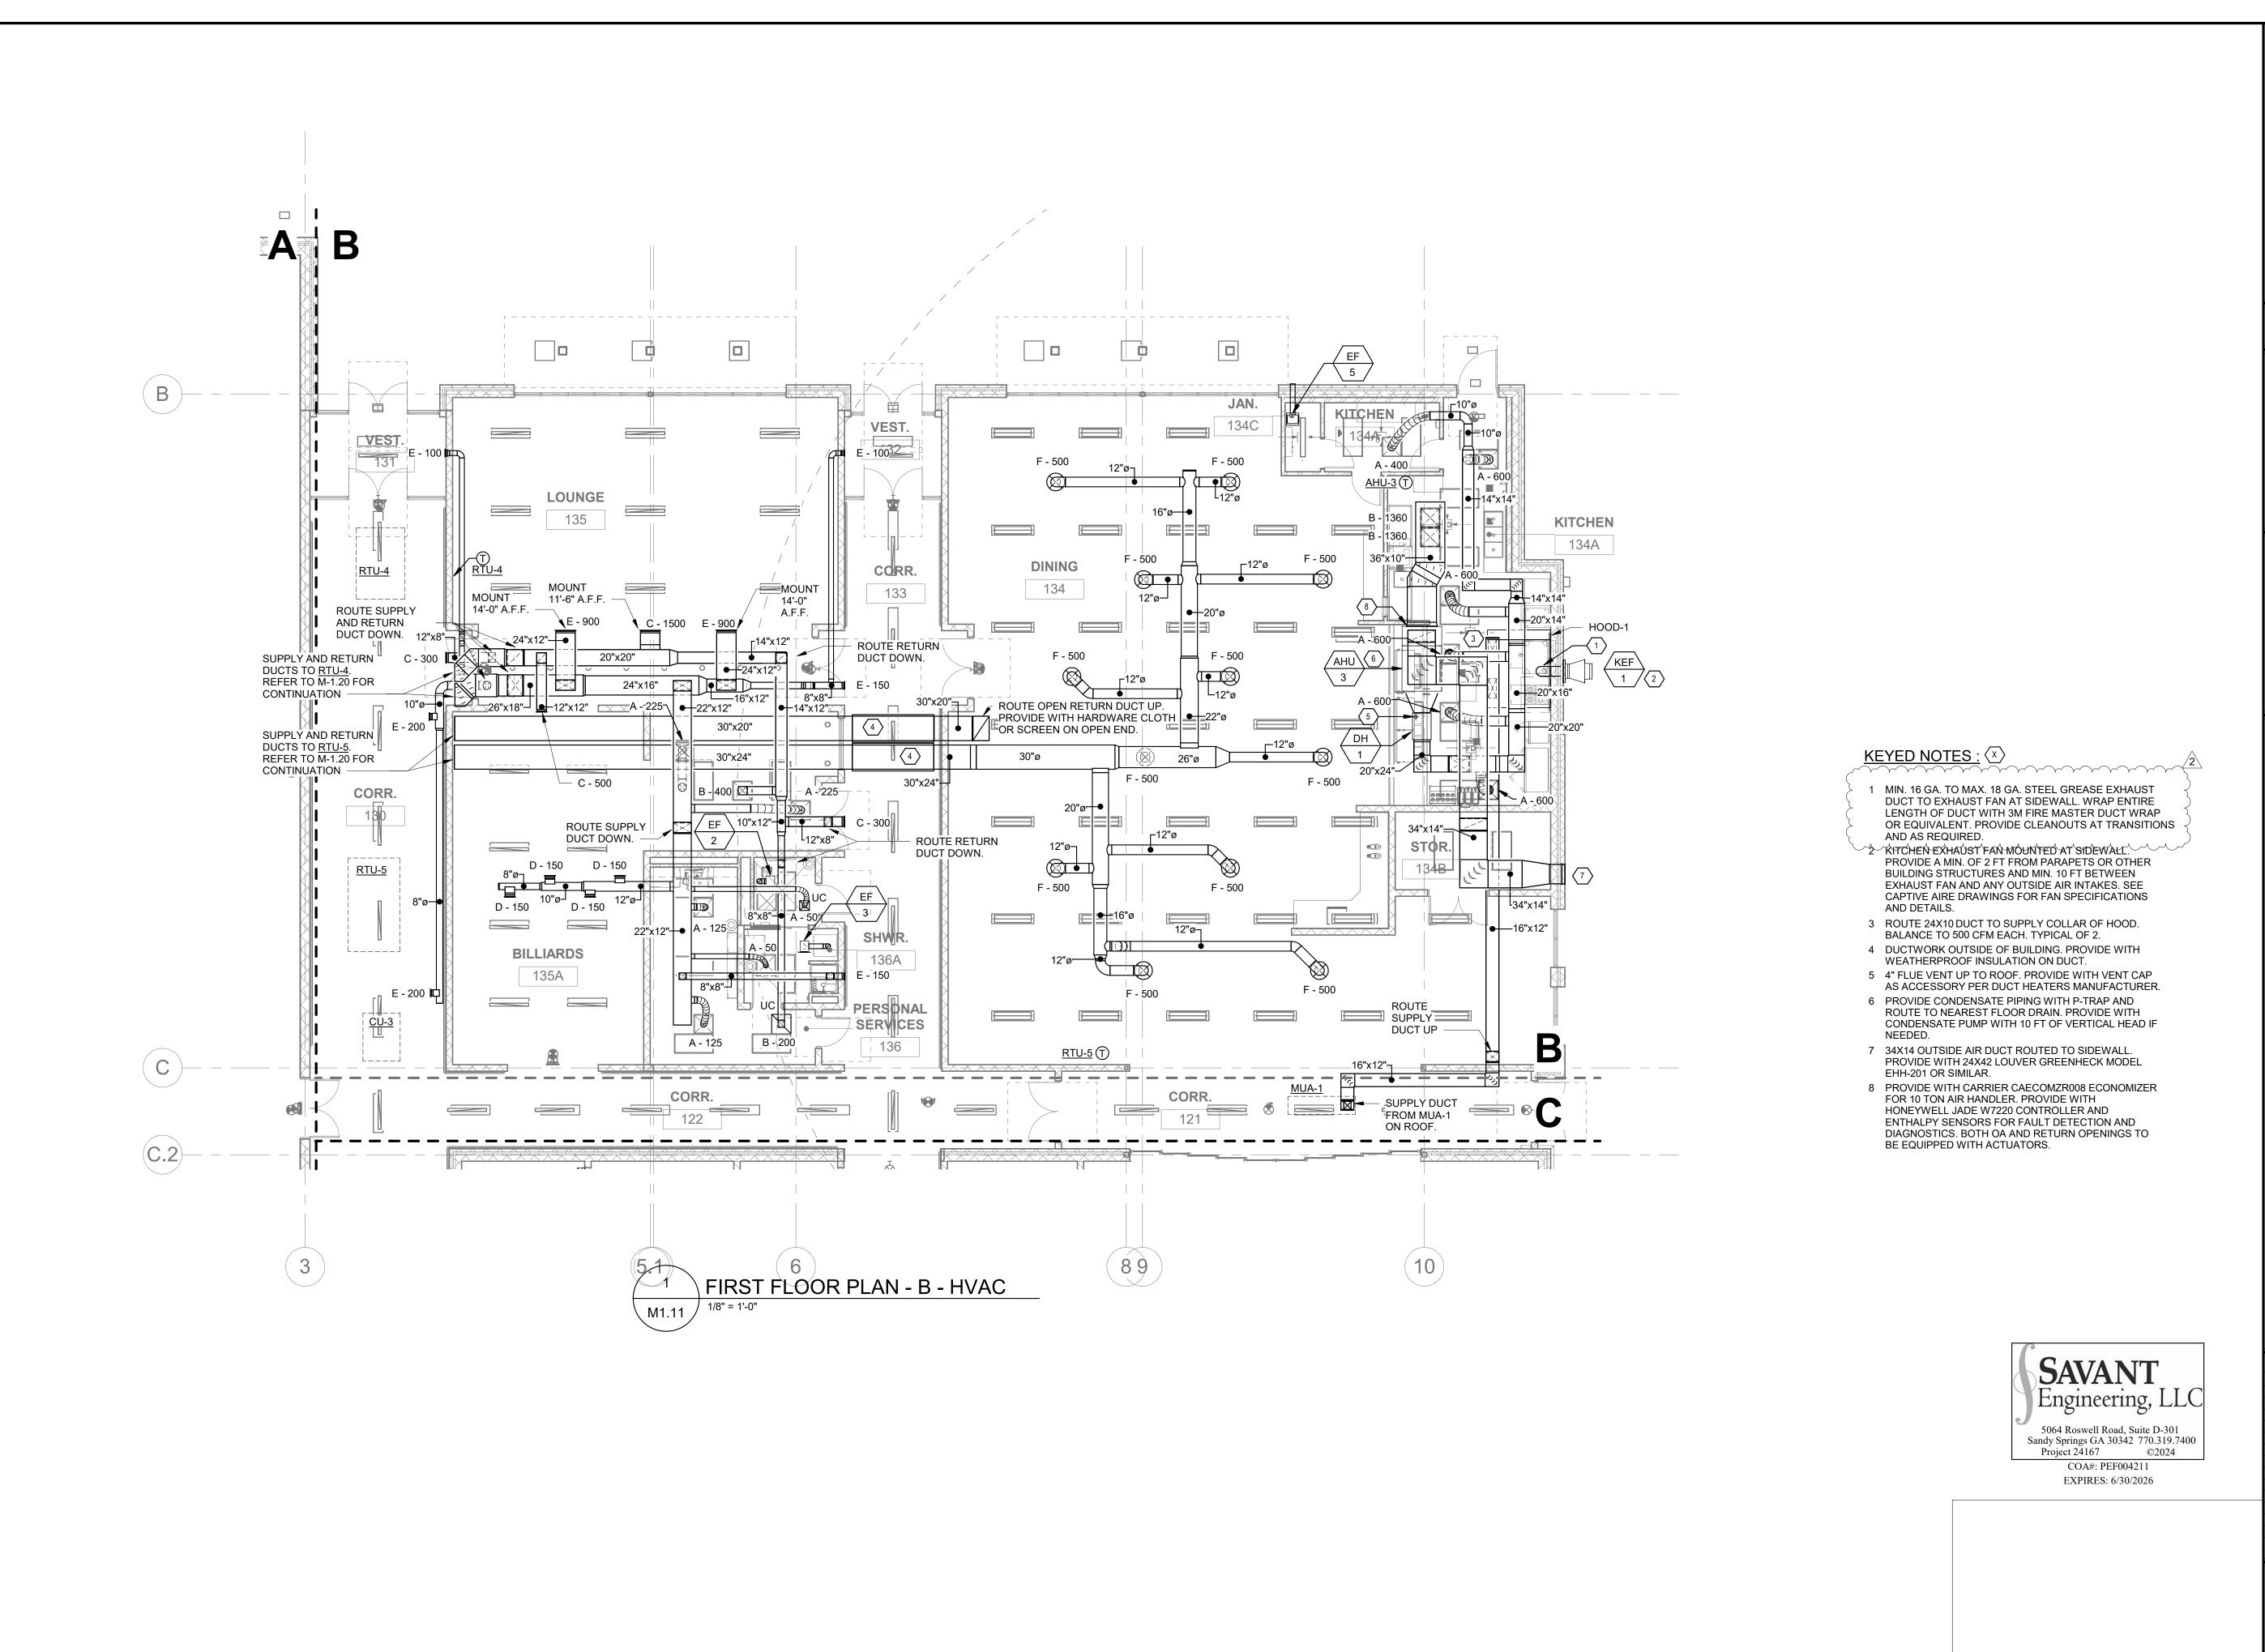

ACULA PARK XPANSION DA TION OF CONSTRUCT ACTIVITY

THIS DRAWING AND THE DESIGN SHOWN IS THE PROPERTY OF THE ARCHITECT. REPRODUCTION, COPYING, OR USE OF THIS DRAWING WITHOUT THEIR WRITTEN CONSENT IS PROHIBITED, AND ANY INFRINGEMENT IS SUBJECT TO LEGAL ACTION.

SUB	MITTALS	6 / REVISIONS
<b>VO</b>	DATE	DESCRIPTION
	11/01/24	Addendum #2

FOR CONSTRUCTION

SHEET TITLE FIRST FLOOR PLAN - B - HVAC

PROJECT NO. **19045-01** DATE 10/03/2024 DRAWN BY SCALE RHR CHECKED BY RGV
SHEET NO. indicated

**GWINNETT CASE# BLD2020-06406** 

M1.11

FIRE		<u>'M INFORMATIO</u>	"		DESIGN FP	INSTALLA	INSTALLATI□N				
YSTEM '	TAG	TYPE	SIZE	MAX FP		SYSTEM	ATION ON HO	DD C			
1		TANK FS	FS 4.0/4.0 40 23 FIRE CABINET LEFT LEF					EFT, HOOD 1			
IRE S	<u>YSTE</u>	<u>'M PARTS LIST</u>	T KEY								
FIRE SYSTEM NO	TAG	KEY NUMBER - PART DESCRIPTION									
		0 - 0 - TANK FIRE SUPPRESSION POST-DISCHARGE PROCEDURE UTILITY CABINET LABEL SHEET.									
		0 - 0 - TANK F	IRE SUPPRESSION MAINTENANCE GUI	DE UTILITY	CABINET	LABEL SHEET.		1	0		
		l .	0 - 0 - 12-F28021-32144-DT-360 DUCT FIRE THERMOSTAT WITH 12 FOOT WIRE LEADS. NO, CLOSE ON TEMP RISE AT 360°F. (A0034310).								
		0 - 0 - 4429K15	2	0							
		0 - 0 - 4429K42	1	0							
1		0 - 0 - 79525 1	1 2	0							
		0 - 0 - 79380 1	_								
		PRIMARY RELEASE	1	0							
		0 - 0 - 87-12004 TANK FIRE SUPPR	1	0							
		0 - 0 - 87-3000	01-001 TANK - PRESSURIZED TANK U	SURIZED TANK USED FOR TANK FIRE SUPPRESSION.							
			0 - 0 - 87-300030-001 PRIMARY ACTUATOR KIT (PAK) - ACTUATOR AND RELEASE SOLENDID ASSEMBLY, ONE NEEDED PER FIRE SYSTEM, SUPERVISED, TANK FIRE SUPPRESSION.								
		0 - 0 - 87-30015	8	0							
		0 - 0 - 98694A115 HARDWARE, DATANKLOCK LOCKING BRACKET SQUARE NUTS 5/16" ZINC, TANK FIRE SUPPRESSION.							0		
		0 - 0 - A0034332 JUNCTION BOX FOR MANUAL PULL STATION. 1.5" DEEP BACK BOX, RED COLOR.							0		
		0 - 0 - A31484 1/4" NPT SCHRADER VALVE AND CAP, JB INDUSTRIES, 1/4" FLARE X 1/4" MPT HALF UNION, USED ON TANK SERVICE PORT.							0		
		0 - 0 - DATANKL IN UTILITY CABIN	2	0							
		0 - 0 - TANK ST	6	0							
		0 - 0 - TFS-UCT CABINETS, TANK F	2	0							
		0 - 0 - WK-2839	2	0							
		34 - 34 - A0034 WITH PR□TECTIVE	1	0							
		ADDITIONAL PART	S TO BE DETERMINED								

Activ 30019 Revoo\_Dacula GA, Dacula,

**DATE:** 10/2/2024 **DWG.#:** 7079567

DRAWN BY: **SCALE:** 3/4" = 1'-0"

SHEET NO.

EXPIRES: 6/30/2026

**SAVANT**Engineering, LLC 5064 Roswell Road, Suite D-301 Sandy Springs GA 30342 770.319.7400 Project 24167 ©2024

FOR REFERENCE ONLY 

HOODS DESIGNED AND PROVIDED BY OTHERS AND INSTALLED BY THE MECHANICAL CONTRACTOR.



CONSTRUCTION OF DACULA PARK
ACTIVITY CENTER EXPANSION
BL 130-24
PREPARED FOR:


NO DATE DESCRIPTION

FOR CONSTRUCTION **CAPTIVE AIRE DRAWINGS** 

PROJECT NO.
19045-01
DRAWN BY
RHR
CHECKED BY
RGV
SHEET NO. DATE 10/03/2024 SCALE

M3.03

GWINNETT CASE# BLD2020-06406

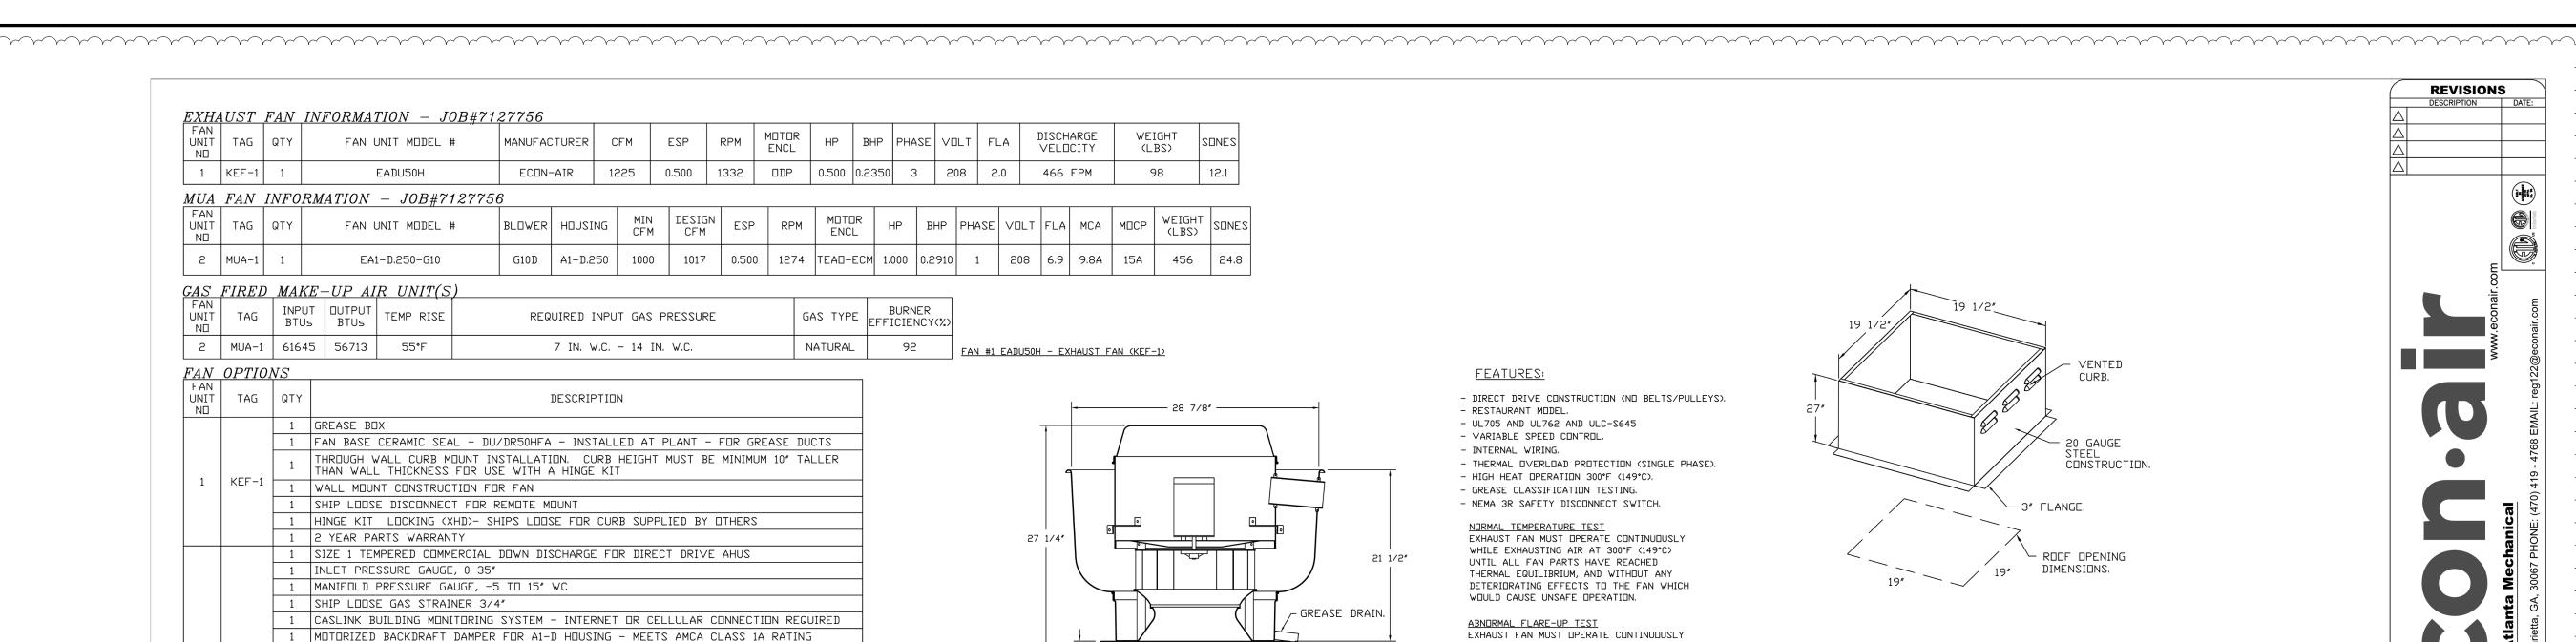

			1	2 YEAR PA	ARTS WA	ARRANTY									
				EXTERIOR BRACKET	GAS CO	NNECTION F	R□∨IDED	BY FACTORY	WITH	QUICK	SEAL	AND	ANTI-	-ROTA	TION
$F_{\mathcal{F}}$	4N	ACCES	SORIE	'S											
	-AN INIT	TAG	TZUAHX3			SUPPLY									
-	ND		GREASE CUP	GRAVITY DAMPER	WALL MOUNT	SIDE DISCHARGE	GRAVITY DAMPER	MOTORIZED DAMPER	WALL MOUNT						
	1	KEF-1	YES							]					
	2	MUA-1						YES							

ROTATION


MUA-1


CUF	RB AS	SSEMBLIES			
ND	□N FAN	TAG	WEIGHT	ITEM	SIZE
1	# 1	KEF−1	35 LBS	CURB	19.500"W X 19.500"L X 27.000"H VENTED.
2	# 2	MUA-1	63 LBS	CURB	21,000"W X 71,000"L X 12,000"H INSULATED.

1 | COMMERCIAL SMOKE DETECTOR/ALARM INTERLOCK - ALARM SUPPLIED BY OTHERS

ECM WIRING PACKAGE-SUPPLY - PWM SIGNAL FROM ECPMO3 PREWIRE (TELCO MOTOR), CW

HMI SCHEDULE											
UNIT NUMBER	HMI #	HMI LOCATION	TEMP	A∨ERAGING	MODBUS ADDRES						
FAN #2	HMI #1 - UNIT	IN UNIT	NDT	AVERAGED	55						

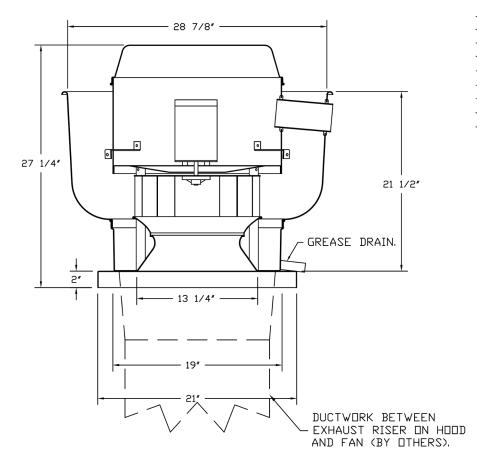

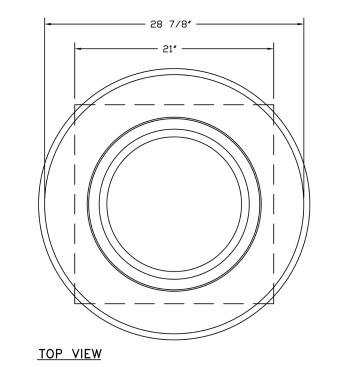

### FEATURES:

- DIRECT DRIVE CONSTRUCTION (NO BELTS/PULLEYS). - RESTAURANT MODEL.
- UL705 AND UL762 AND ULC-S645 - VARIABLE SPEED CONTROL. - INTERNAL WIRING.
- THERMAL OVERLOAD PROTECTION (SINGLE PHASE). - HIGH HEAT OPERATION 300°F (149°C). - GREASE CLASSIFICATION TESTING.
- NEMA 3R SAFETY DISCONNECT SWITCH. NORMAL TEMPERATURE TEST EXHAUST FAN MUST OPERATE CONTINUOUSLY WHILE EXHAUSTING AIR AT 300°F (149°C)
- UNTIL ALL FAN PARTS HAVE REACHED THERMAL EQUILIBRIUM, AND WITHOUT ANY DETERIORATING EFFECTS TO THE FAN WHICH WOULD CAUSE UNSAFE OPERATION.

ABNORMAL FLARE-UP TEST EXHAUST FAN MUST OPERATE CONTINUOUSLY WHILE EXHAUSTING BURNING GREASE VAPORS AT 600°F (316°C) FOR A PERIOD OF 15 MINUTES WITHOUT THE FAN BECOMING DAMAGED TO ANY EXTENT THAT COULD CAUSE AN UNSAFE CONDITION.

### 


- GREASE BOX. - FAN BASE CERAMIC SEAL - DU/DR50HFA - INSTALLED AT PLANT - FOR GREASE


DUCTS.

- THROUGH WALL CURB MOUNT
INSTALLATION. CURB HEIGHT MUST BE
MINIMUM 10" TALLER THAN WALL
THICKNESS FOR USE WITH A HINGE KIT.

- WALL MOUNT CONSTRUCTION FOR FAN. - SHIP LOOSE DISCONNECT FOR REMOTE MOUNT.

DPENING. → WALL SUBSTRATE. • • • • HINGE KIT LOCKING (XHD)- SHIPS
LOOSE FOR CURB SUPPLIED BY OTHERS.
- 2 YEAR PARTS WARRANTY. WALL OPENING. CURB HEIGHT.

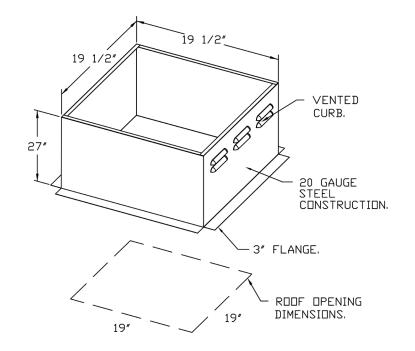

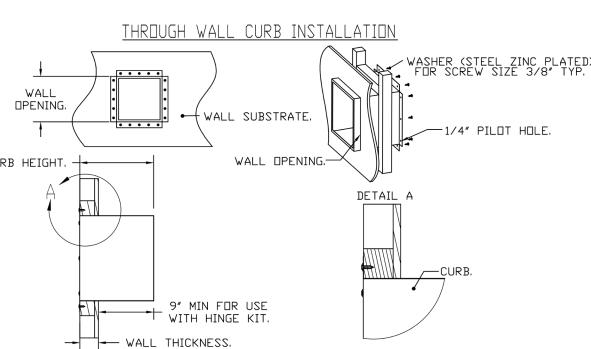



**REVISIONS** 

30019

GA,

Cula

**DATE:** 10/25/2024

DWG.#: 7127756

**SCALE:** 3/4" = 1'-0"

**MASTER DRAWING** 

SHEET NO.

Dacula

\ 01

**8** 

JLA PARK NSION

CULA (PANS

CONSTRUCT ACTIVITY

DA

THIS DRAWING AND THE DESIGN SHOWN IS THE PROPERTY OF THE ARCHITECT. REPRODUCTION, COPYING, OR USE OF THIS DRAWING WITHOUT THEIR WRITTEN CONSENT IS PROHIBITED, AND ANY INFRINGEMENT IS SUBJECT TO LEGAL ACTION.

NO DATE DESCRIPTION

FOR CONSTRUCTION

**CAPTIVE AIRE DRAWINGS** 

PROJECT NO. **19045-01** DATE 10/03/2024 RHR
CHECKED BY
RGV
SHEET NO.

M3.04

**GWINNETT CASE# BLD2020-06406** 

**SAVANT**Engineering, LLC

5064 Roswell Road, Suite D-301 Sandy Springs GA 30342 770.319.7400 Project 24167 ©2024

EXPIRES: 6/30/2026

HOODS DESIGNED AND PROVIDED BY OTHERS AND INSTALLED BY THE MECHANICAL CONTRACTOR.